


- NOTES**
1. ALL LEVELS ARE IN METERS ABOVE SEA LEVEL.
 2. COORDINATES ARE BASED ON UTM.
 3. LOCATION OF AIR VALVES, WASHOUTS, BENDS AND OTHER FITTINGS AS SHOWN UNLESS OTHERWISE DIRECTED BY THE ENGINEER ON SITE.
 4. GROUND AND INVERT LEVEL SHOWN ARE AS SHOWN ON DRAWING UNLESS OTHERWISE INDICATED ON SITE BY THE ENGINEER.
 5. PIPES ARE TO BE LAID TO EVEN GRADIENTS WITH A MINIMUM COVER OF 1.0M WHERE COVER IS LESS THAN THIS, PIPE TO BE SURROUNDED WITH CONCRETE.
 6. ALL BENDS ARE HORIZONTAL UNLESS OTHERWISE STATED.
 7. IN WATER LOGGED AREAS, PIPES TO BE BEDDED WITH SINGLE SIZED OR GRADED AGGREGATES AS PER CLAUSE 430.1 AND 216 OF TECHNICAL SPECIFICATIONS AND/OR ANCHOR BLOCKS AS MAY BE DIRECTED ON SITE BY THE ENGINEER.

- LEGEND:**
- PROPOSED PIPELINE
 - EXISTING GROUND PROFILE
 - PIPE INVERT PROFILE
 - EXISTING ROAD
 - ◇ — AIR VALVE
 - DAV — DOUBLE AIR VALVE
 - ▽ — WASHOUT
 - WO1 — WASHOUT TYPE 1
 - WO2 — WASHOUT TYPE 2
 - DN — NOMINAL DIAMETER
 - PN — NOMINAL PRESSURE
 - VB — VERTICAL BEND
 - HB — HORIZONTAL BEND
 - ▨ — EXISTING STRUCTURE
 - ER — EARTH ROAD
 - GR — GRAVEL ROAD
 - CUT

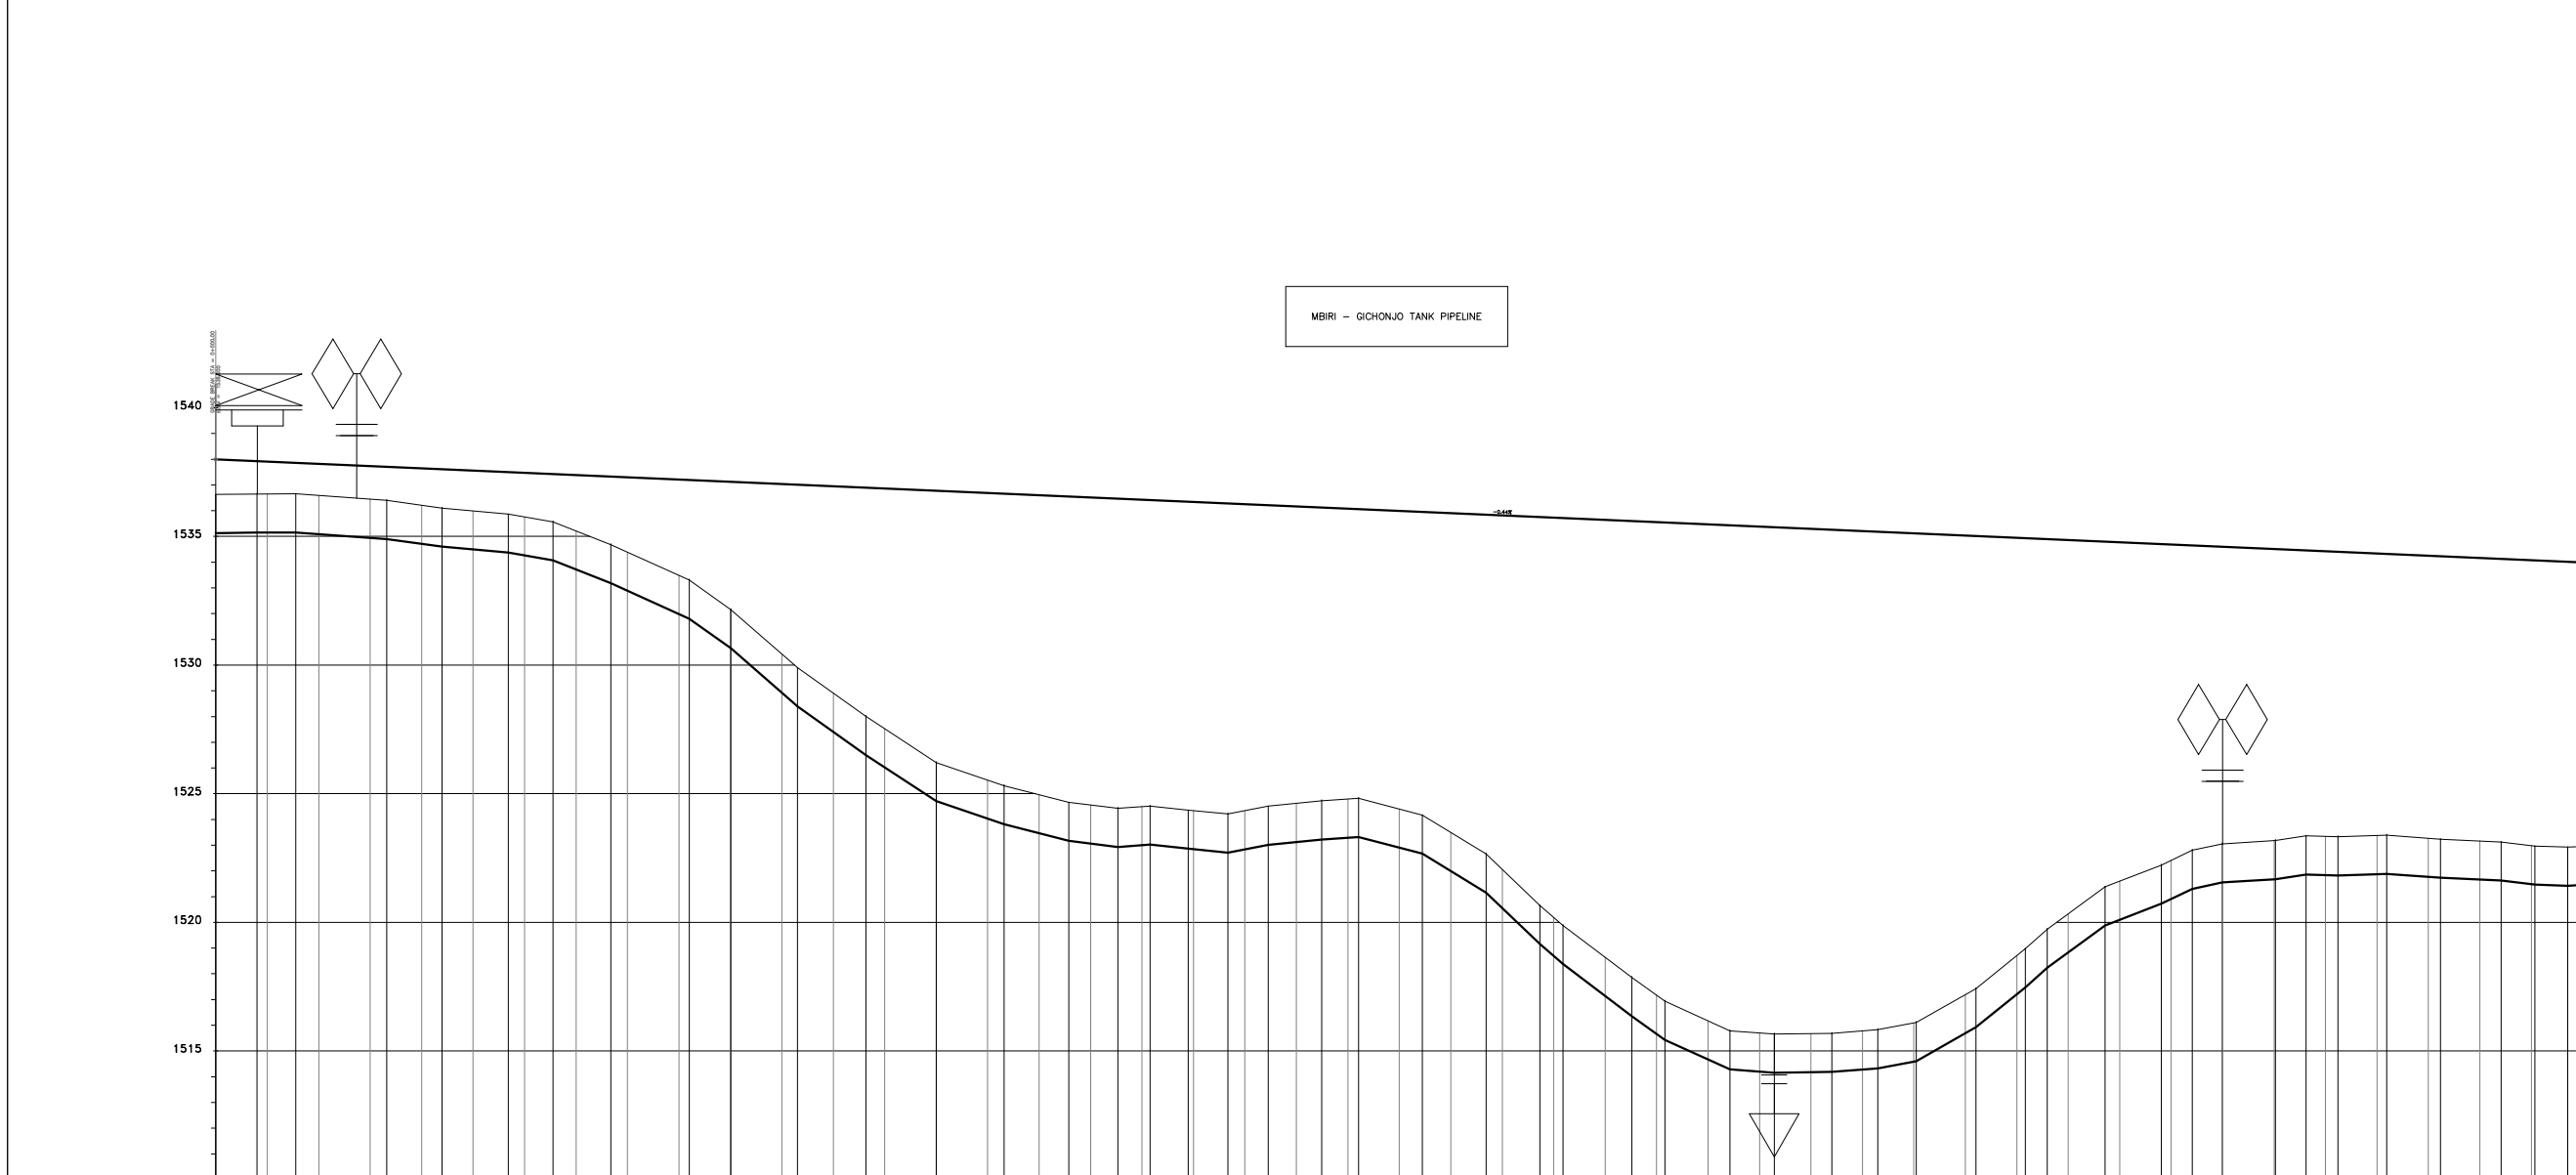

MBIRI - GICHONJO TANK PIPELINE

FOR CONSTRUCTION

REV	REVISIONS	SIGN	DATE	APPROVED
	BY			
	CHECKED			
	BY			
	CHECKED			
	BY			
	CHECKED			
GO	BY			
	CHECKED			

CLIENT

TANA WATER WORKS DEVELOPMENT AGENCY
P. O. BOX 1292-10100
NYERI

PROJECT
NGARIAMA NJUKIINI WATER PROJECT

Civil/Structural Engineers

TANA WATER WORKS DEVELOPMENT AGENCY
P. O. BOX 1292-10100
NYERI

Drawing Title
NGARIAMA NJUKIINI WATER PROJECT
MBIRI-GICHONJO PIPELINE
PLAN AND PROFILE (SHEET 1 OF 6)

CHAINAGE (m)	EXISTING GROUND LEVEL (m)	INVERT LEVELS (m)	H.G.L (m) DATUM (m)	TYPE OF PIPE AND SIZE
0+020.0	1536.65	1535.15	1536.65	PN 10 110MM HDPE PIPE
0+040.0	1536.59	1535.09	1536.59	PN 10 110MM HDPE PIPE
0+060.0	1536.45	1534.95	1536.45	PN 10 110MM HDPE PIPE
0+080.0	1536.21	1534.71	1536.21	PN 10 110MM HDPE PIPE
0+100.0	1535.99	1534.49	1535.99	PN 10 110MM HDPE PIPE
0+120.0	1535.76	1534.26	1535.76	PN 10 110MM HDPE PIPE
0+140.0	1535.21	1533.71	1535.21	PN 10 110MM HDPE PIPE
0+160.0	1534.39	1532.89	1534.39	PN 10 110MM HDPE PIPE
0+180.0	1533.48	1531.98	1533.48	PN 10 110MM HDPE PIPE
0+200.0	1532.17	1530.67	1532.17	PN 10 110MM HDPE PIPE
0+220.0	1530.43	1528.93	1530.43	PN 10 110MM HDPE PIPE
0+240.0	1528.81	1527.41	1528.81	PN 10 110MM HDPE PIPE
0+260.0	1527.53	1526.03	1527.53	PN 10 110MM HDPE PIPE
0+280.0	1526.21	1524.71	1526.21	PN 10 110MM HDPE PIPE
0+300.0	1525.53	1524.03	1525.53	PN 10 110MM HDPE PIPE
0+320.0	1524.96	1523.46	1524.96	PN 10 110MM HDPE PIPE
0+340.0	1524.56	1523.06	1524.56	PN 10 110MM HDPE PIPE
0+360.0	1524.50	1523.00	1524.50	PN 10 110MM HDPE PIPE
0+380.0	1524.34	1522.84	1524.34	PN 10 110MM HDPE PIPE
0+400.0	1524.34	1522.84	1524.34	PN 10 110MM HDPE PIPE
0+420.0	1524.62	1523.12	1524.62	PN 10 110MM HDPE PIPE
0+440.0	1524.79	1523.29	1524.79	PN 10 110MM HDPE PIPE
0+460.0	1524.40	1522.90	1524.40	PN 10 110MM HDPE PIPE
0+480.0	1523.50	1522.00	1523.50	PN 10 110MM HDPE PIPE
0+500.0	1522.06	1520.56	1522.06	PN 10 110MM HDPE PIPE
0+520.0	1520.19	1518.69	1520.19	PN 10 110MM HDPE PIPE
0+540.0	1518.64	1517.14	1518.64	PN 10 110MM HDPE PIPE
0+560.0	1517.17	1515.67	1517.17	PN 10 110MM HDPE PIPE
0+580.0	1516.17	1514.67	1516.17	PN 10 110MM HDPE PIPE
0+600.0	1515.70	1514.20	1515.70	PN 10 110MM HDPE PIPE
0+620.0	1515.68	1514.18	1515.68	PN 10 110MM HDPE PIPE
0+640.0	1515.78	1514.28	1515.78	PN 10 110MM HDPE PIPE
0+660.0	1516.09	1514.59	1516.09	PN 10 110MM HDPE PIPE
0+680.0	1517.19	1515.69	1517.19	PN 10 110MM HDPE PIPE
0+700.0	1518.71	1517.21	1518.71	PN 10 110MM HDPE PIPE
0+720.0	1520.33	1518.83	1520.33	PN 10 110MM HDPE PIPE
0+740.0	1521.60	1520.10	1521.60	PN 10 110MM HDPE PIPE
0+760.0	1522.41	1520.91	1522.41	PN 10 110MM HDPE PIPE
0+780.0	1523.05	1521.55	1523.05	PN 10 110MM HDPE PIPE
0+800.0	1523.17	1521.67	1523.17	PN 10 110MM HDPE PIPE
0+820.0	1523.34	1521.84	1523.34	PN 10 110MM HDPE PIPE
0+840.0	1523.38	1521.88	1523.38	PN 10 110MM HDPE PIPE
0+860.0	1523.27	1521.77	1523.27	PN 10 110MM HDPE PIPE
0+880.0	1523.17	1521.67	1523.17	PN 10 110MM HDPE PIPE
0+900.0	1522.98	1521.48	1522.98	PN 10 110MM HDPE PIPE

REMARKS.	S.V	A.V	W.O	S.V
PIPE FLOW DATA	0.0081M ³ /S			

Designed by DWN	Drawn by EWN
Checked by JMM	Approved by
Scale AS SHOWN (A1)	Date MAY, 2022
Job No. 1	ACAD File:
C STATUS	DRAWING NoJWWDA/NNWP/MG-001