

- NOTES**
- ALL LEVELS ARE IN METERS ABOVE SEA LEVEL.
 - COORDINATES ARE BASED ON UTM.
 - LOCATION OF AIR VALVES, WASHOUTS, BENDS AND OTHER FITTINGS AS SHOWN UNLESS OTHERWISE DIRECTED BY THE ENGINEER ON SITE.
 - GROUND AND INVERT LEVEL SHOWN ARE AS SHOWN ON DRAWING UNLESS OTHERWISE INDICATED ON SITE BY THE ENGINEER.
 - PIPES ARE TO BE LAID TO EVEN GRADIENTS WITH A MINIMUM COVER OF 1.0M. WHERE COVER IS LESS THAN THIS, PIPE TO BE SURROUNDED WITH CONCRETE.
 - ALL BENDS ARE HORIZONTAL UNLESS OTHERWISE STATED.
 - IN WATER LOGGED AREAS, PIPES TO BE BEDDED WITH SINGLE SIZED OR GRADED AGGREGATES AS PER CLAUSE 430.1 AND 216 OF TECHNICAL SPECIFICATIONS AND/OR ANCHOR BLOCKS AS MAY BE DIRECTED ON SITE BY THE ENGINEER.
- LEGEND:**
- PROPOSED PIPELINE
 - - - - - EXISTING GROUND PROFILE
 - PIPE INVERT PROFILE
 - EXISTING ROAD

- AIR VALVE
- DOUBLE AIR VALVE
- WASHOUT
- WO1 — WASHOUT TYPE 1
- WO2 — WASHOUT TYPE 2
- DN — NOMINAL DIAMETER
- PN — NOMINAL PRESSURE
- VB — VERTICAL BEND
- HB — HORIZONTAL BEND
- EXISTING STRUCTURE
- ER — EARTH ROAD
- GR — GRAVEL ROAD
- CUT

FOR CONSTRUCTION
signed CMTS

REV	REVISIONS	SIGN	DATE	APPROVED
	BY			
	CHECKED			
	BY			
	CHECKED			
	BY			
	CHECKED			
CO	ISSUED FOR CONSTRUCTION BY			
	CHECKED			

CLIENT

TANA WATER WORKS
DEVELOPMENT AGENCY
P. O. BOX 1292-10100
NYERI

PROJECT

DESIGNS FOR AUGMENTATION OF
TIGITHI-HUMUKA WATER PROJECT


Civil/Structural Engineers

TANA WATER WORKS
DEVELOPMENT AGENCY
P. O. BOX 1292-10100
NYERI

Drawing Title

WERUINI TANK SUPPLY
LINE 2
PLAN AND PROFILE (SHEET 1 OF 1)

Designed by KNG	Drawn by MK
Checked by JMM	Approved by
Scale AS SHOWN (A1)	Date SEPTEMBER 2023
Job No. 1	ACAD File:
PD STATUS	DRAWING NoTWJDA/THWP/WTS2/01
	CO REV

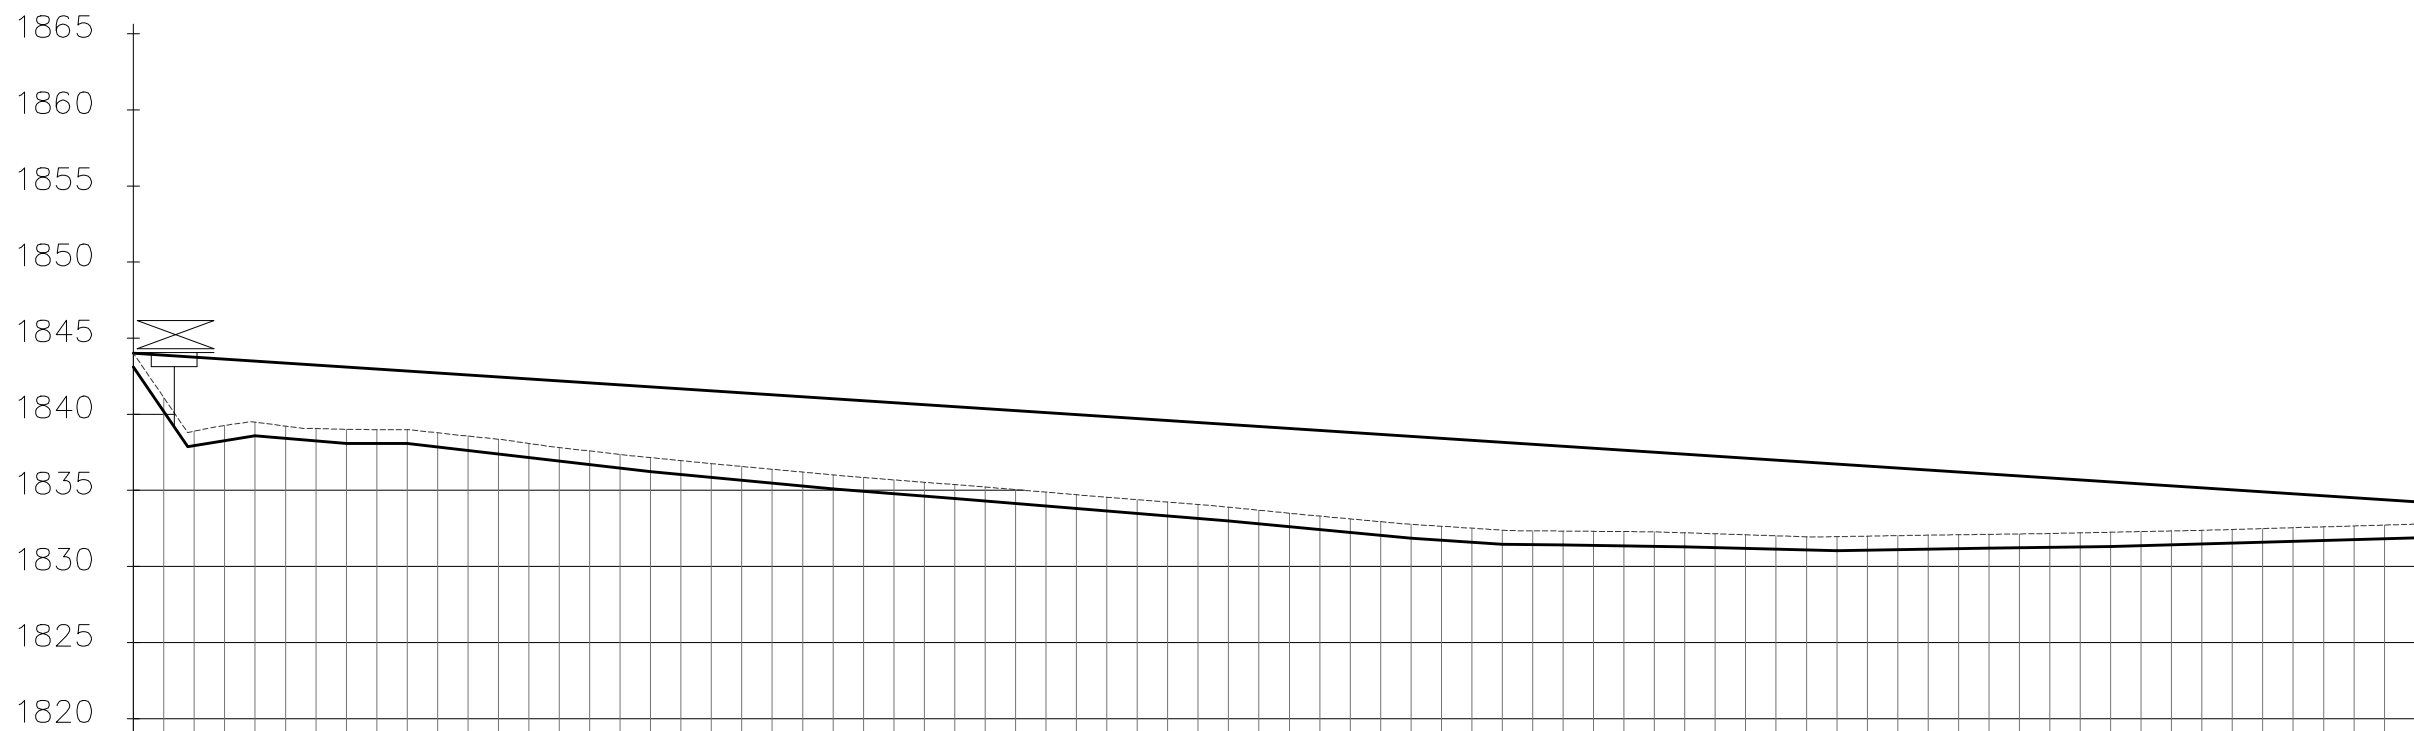

DISTANCE DATUM (m)	GROUND LEVELS (m)	INVERT LEVELS(m)	DEPTH FROM GROUND LEVEL TO INVERT LEVEL (m)	HGL(m)	TYPE OF PIPE AND SIZE
0+000.00	1844.01	1843.10	0.92	1844.01	PN10 00115.4MM PVC PIPE
0+020.00	1843.88	1843.10	0.91	1843.88	PN10 00115.4MM PVC PIPE
0+040.00	1843.75	1843.10	0.94	1843.75	PN10 00115.4MM PVC PIPE
0+060.00	1843.62	1843.10	0.95	1843.62	PN10 00115.4MM PVC PIPE
0+080.00	1843.49	1843.10	0.88	1843.49	PN10 00115.4MM PVC PIPE
0+100.00	1843.36	1843.10	0.80	1843.36	PN10 00115.4MM PVC PIPE
0+120.00	1843.23	1843.10	0.80	1843.23	PN10 00115.4MM PVC PIPE
0+140.00	1843.10	1843.10	0.92	1843.10	PN10 00115.4MM PVC PIPE
0+160.00	1842.97	1843.10	0.91	1842.97	PN10 00115.4MM PVC PIPE
0+180.00	1842.84	1843.10	0.91	1842.84	PN10 00115.4MM PVC PIPE
0+200.00	1842.71	1843.10	0.94	1842.71	PN10 00115.4MM PVC PIPE
0+220.00	1842.58	1843.10	0.95	1842.58	PN10 00115.4MM PVC PIPE
0+240.00	1842.45	1843.10	0.98	1842.45	PN10 00115.4MM PVC PIPE
0+260.00	1842.32	1843.10	0.93	1842.32	PN10 00115.4MM PVC PIPE
0+280.00	1842.19	1843.10	0.89	1842.19	PN10 00115.4MM PVC PIPE
0+300.00	1842.06	1843.10	0.89	1842.06	PN10 00115.4MM PVC PIPE
0+320.00	1841.93	1843.10	0.89	1841.93	PN10 00115.4MM PVC PIPE
0+340.00	1841.80	1843.10	0.92	1841.80	PN10 00115.4MM PVC PIPE
0+360.00	1841.67	1843.10	0.91	1841.67	PN10 00115.4MM PVC PIPE
0+380.00	1841.54	1843.10	0.90	1841.54	PN10 00115.4MM PVC PIPE
0+400.00	1841.41	1843.10	0.91	1841.41	PN10 00115.4MM PVC PIPE
0+420.00	1841.28	1843.10	0.91	1841.28	PN10 00115.4MM PVC PIPE
0+440.00	1841.15	1843.10	0.91	1841.15	PN10 00115.4MM PVC PIPE
0+460.00	1841.02	1843.10	0.92	1841.02	PN10 00115.4MM PVC PIPE
0+480.00	1840.89	1843.10	0.91	1840.89	PN10 00115.4MM PVC PIPE
0+500.00	1840.76	1843.10	0.90	1840.76	PN10 00115.4MM PVC PIPE
0+520.00	1840.63	1843.10	0.90	1840.63	PN10 00115.4MM PVC PIPE
0+540.00	1840.50	1843.10	0.90	1840.50	PN10 00115.4MM PVC PIPE
0+560.00	1840.37	1843.10	0.91	1840.37	PN10 00115.4MM PVC PIPE
0+580.00	1840.24	1843.10	0.91	1840.24	PN10 00115.4MM PVC PIPE
0+600.00	1840.11	1843.10	0.90	1840.11	PN10 00115.4MM PVC PIPE
0+620.00	1839.98	1843.10	0.90	1839.98	PN10 00115.4MM PVC PIPE
0+640.00	1839.85	1843.10	0.90	1839.85	PN10 00115.4MM PVC PIPE
0+660.00	1839.72	1843.10	0.90	1839.72	PN10 00115.4MM PVC PIPE
0+680.00	1839.59	1843.10	0.90	1839.59	PN10 00115.4MM PVC PIPE
0+700.00	1839.46	1843.10	0.91	1839.46	PN10 00115.4MM PVC PIPE
0+720.00	1839.33	1843.10	0.90	1839.33	PN10 00115.4MM PVC PIPE
0+740.00	1839.20	1843.10	0.89	1839.20	PN10 00115.4MM PVC PIPE
0+760.00	1839.07	1843.10	0.89	1839.07	PN10 00115.4MM PVC PIPE
0+780.00	1838.94	1843.10	0.89	1838.94	PN10 00115.4MM PVC PIPE
0+800.00	1838.81	1843.10	0.89	1838.81	PN10 00115.4MM PVC PIPE
0+820.00	1838.68	1843.10	0.90	1838.68	PN10 00115.4MM PVC PIPE
0+840.00	1838.55	1843.10	0.92	1838.55	PN10 00115.4MM PVC PIPE
0+860.00	1838.42	1843.10	0.92	1838.42	PN10 00115.4MM PVC PIPE
0+880.00	1838.29	1843.10	0.92	1838.29	PN10 00115.4MM PVC PIPE
0+900.00	1838.16	1843.10	0.93	1838.16	PN10 00115.4MM PVC PIPE
0+920.00	1838.03	1843.10	0.91	1838.03	PN10 00115.4MM PVC PIPE
0+940.00	1837.90	1843.10	0.91	1837.90	PN10 00115.4MM PVC PIPE
0+960.00	1837.76	1843.10	0.92	1837.76	PN10 00115.4MM PVC PIPE
0+980.00	1837.63	1843.10	0.94	1837.63	PN10 00115.4MM PVC PIPE
1+000.00	1837.50	1843.10	0.95	1837.50	PN10 00115.4MM PVC PIPE
1+020.00	1837.37	1843.10	0.92	1837.37	PN10 00115.4MM PVC PIPE
1+040.00	1837.24	1843.10	0.90	1837.24	PN10 00115.4MM PVC PIPE
1+060.00	1837.11	1843.10	0.89	1837.11	PN10 00115.4MM PVC PIPE
1+080.00	1836.98	1843.10	0.87	1836.98	PN10 00115.4MM PVC PIPE
1+100.00	1836.85	1843.10	0.86	1836.85	PN10 00115.4MM PVC PIPE
1+120.00	1836.72	1843.10	0.91	1836.72	PN10 00115.4MM PVC PIPE
1+140.00	1836.59	1843.10	0.91	1836.59	PN10 00115.4MM PVC PIPE
1+160.00	1836.46	1843.10	0.92	1836.46	PN10 00115.4MM PVC PIPE
1+180.00	1836.33	1843.10	0.92	1836.33	PN10 00115.4MM PVC PIPE
1+200.00	1836.20	1843.10	0.91	1836.20	PN10 00115.4MM PVC PIPE
1+220.00	1836.07	1843.10	0.91	1836.07	PN10 00115.4MM PVC PIPE
1+240.00	1835.94	1843.10	0.90	1835.94	PN10 00115.4MM PVC PIPE
1+260.00	1835.81	1843.10	0.91	1835.81	PN10 00115.4MM PVC PIPE
1+280.00	1835.68	1843.10	0.92	1835.68	PN10 00115.4MM PVC PIPE
1+300.00	1835.55	1843.10	0.93	1835.55	PN10 00115.4MM PVC PIPE
1+320.00	1835.42	1843.10	0.92	1835.42	PN10 00115.4MM PVC PIPE
1+340.00	1835.29	1843.10	0.90	1835.29	PN10 00115.4MM PVC PIPE
1+360.00	1835.16	1843.10	0.89	1835.16	PN10 00115.4MM PVC PIPE
1+380.00	1835.03	1843.10	0.89	1835.03	PN10 00115.4MM PVC PIPE
1+400.00	1834.90	1843.10	0.89	1834.90	PN10 00115.4MM PVC PIPE
1+420.00	1834.77	1843.10	0.89	1834.77	PN10 00115.4MM PVC PIPE
1+440.00	1834.64	1843.10	0.89	1834.64	PN10 00115.4MM PVC PIPE
1+460.00	1834.51	1843.10	0.89	1834.51	PN10 00115.4MM PVC PIPE
1+480.00	1834.38	1843.10	0.89	1834.38	PN10 00115.4MM PVC PIPE
1+500.00	1834.25	1843.10	0.89	1834.25	PN10 00115.4MM PVC PIPE

Thome Tank Supply Line 2
SCALE: HOR 1:2000 VERT 1:1000