



Mwiyogo Tank Supply Line 2 SCALE: HOR 1:2000 VERT 1:1000

	NOTES
$\land$ $\land$	1. ALL LEVELS ARE IN METERS ABOVE SEA LEVEL.
	2. COORDINATES ARE BASED ON UTM.
	<ol> <li>LOCATION OF AIR VALVES, WASHOUTS, BENDS AND OTHER FITTINGS AS SHOWN UNLESS OTHERWISE DIRECTED BY THE ENGINEER ON SITE.</li> </ol>
	<ol> <li>GROUND AND INVERT LEVEL SHOWN ARE AS SHOWN ON DRAWING UNLESS OTHERWISE INDICATED ON SITE BY THE ENGINEER.</li> </ol>
220° ###	5. PIPES ARE TO BE LAID TO EVEN GRADIENTS WITH A MINIMUM COVER OF 1.0M. WHERE COVER IS LESS THAN THIS, PIPE TO BE SURROUNDED WITH
	CONCRETE. 6. ALL BENDS ARE HORIZONTAL UNLESS OTHERWISE STATED.
	<ol> <li>IN WATER LOGGED AREAS, PIPES TO BE BEDDED WITH SINGLE SIZED OR GRADED AGGREGATES AS PER CLAUSE 430.1 AND 216 OF TECHNICAL SPECIFICATIONS AND/OR ANCHOR BLOCKS AS MAY BE DIRECTED ON SITE BY THE ENGINEER.</li> </ol>
	LEGEND:     PROPOSED PIPELINE     EXISTING GROUND PROFILE     PIPE INVERT PROFILE     EXISTING ROAD
	+ - AIR VALVE
	DAV – DOUBLE AIR VALVE
	- WASHOUT
	WO1 – WASHOUT TYPE 1 WO2 – WASHOUT TYPE 2
	DN – NOMINAL DIAMETER
	PN – NOMINAL PRESSURE
	VB – VERTICAL BEND HB – HORIZONTAL BEND
	- EXISTING STRUCTURE
	ER – EARTH ROAD GR – GRAVEL ROAD
	Unit – CUT
	FOR CONSTRUCTION signed CMTS
	REV         R E V I S I O N S         SIGN         DATE         APPROVED
	BY CHECKED
	BY CHECKED
	BY CHECKED
	CO ISSUED FOR CONSTRUCTION BY CHECKED
	CLIENT TANA WATER WORKS DEVELOPMENT AGENCY P. O. BOX 1292-10100 NYERI
13     15.55.01     1+500.00       44     1836.55     1+620.00       01     1835.90     1+660.00       28     1837.18     1+660.00       28     1837.13     1+700.00       55     1837.73     1+720.00       13     1838.01     1+740.00       45     1838.67     1+740.00       76     1838.67     1+780.00       76     1838.67     1+780.00       76     1838.67     1+820.00       28     1839.43     1+820.00	PROJECT DESIGNS FOR AUGMENTATION OF TIGITHI-HUMUKA WATER PROJECT
	Civil/Structural Engineers
10000-01     10000-01     10000-00       1835.44     1835.53     1+640.00       1835.07     1835.62     1+640.00       1835.07     1835.73     1+760.00       1835.07     1835.73     1+700.00       1835.25     1837.43     1+700.00       1835.25     1837.73     1+720.00       1835.82     1837.73     1+720.00       1837.45     1838.01     1+740.00       1837.45     1838.03     1+740.00       1837.86     1+760.00     1837.86       1837.86     1+760.00     1837.86       1837.86     1+760.00     1837.86       1837.86     1+760.00     1838.86       1837.86     1+760.00     1838.86       1837.86     1+760.00     1838.86       1837.86     1+760.00     1838.86       1838.87     1838.90     18420.00       1838.83     18339.43     1+830.00       1838.83     18339.43     1+830.00	TANA WATER WORKS DEVELOPMENT AGENCY P. O. BOX 1292-10100 NYERI
1854.56         0.91           1854.56         0.91           1855.63         0.90           1855.63         0.90           1855.63         0.90           1855.63         0.90           1855.01         0.91           1855.03         0.90           1855.04         0.91           1855.05         0.91           1855.00         0.91           1855.01         0.91           1855.03         0.90           1855.04         0.91           1855.03         0.90           1855.04         0.85           1855.05         0.91           1855.06         0.91           1855.07         0.91           1851.24         0.92           1851.24         0.92           1851.24         0.92	MWIYOGO TANK SUPPLY LINE 2 PLAN AND PROFILE (SHEET 1 OF 2)
	Designed by KNG Drawn by MK Checked by JMM Approved by
	Scale AS SHOWN (A1) Date SEPTEMBER 2023
	Job No. 1 ACAD File:
	PD STATUS DRAWING No.TWWDA/THWP/MTL2/0 REV

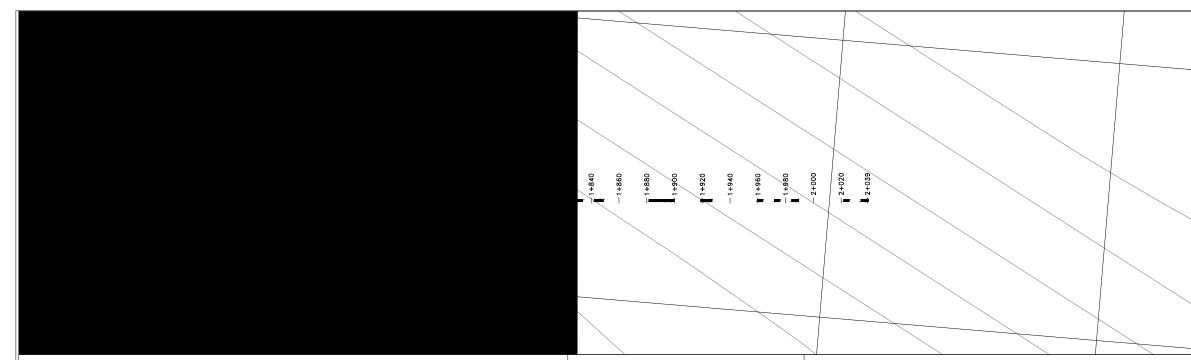

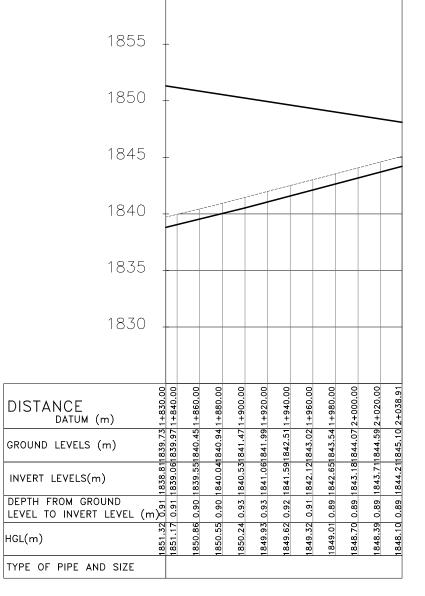

M<del>wiyogo </del>™appkms90⊄pp<mark>ply Line −</mark>2 SCALE: HOR 1:2000 VERT 1:1000

	NOTES
	1. ALL LEVELS ARE IN METERS ABOVE SEA LEVEL.
	2. COORDINATES ARE BASED ON UTM.
	<ol> <li>LOCATION OF AIR VALVES, WASHOUTS, BENDS AND OTHER FITTINGS AS SHOWN UNLESS OTHERWISE DIRECTED BY THE ENGINEER ON SITE.</li> </ol>
	<ol> <li>GROUND AND INVERT LEVEL SHOWN ARE AS SHOWN ON DRAWING UNLESS OTHERWISE INDICATED ON SITE BY THE ENGINEER.</li> </ol>
	5. PIPES ARE TO BE LAID TO EVEN GRADIENTS WITH A MINIMUM COVER OF 1.0M. WHERE COVER IS LESS THAN THIS, PIPE TO BE SURROUNDED WITH
	CONCRETE.
	6. ALL BENDS ARE HORIZONTAL UNLESS OTHERWISE STATED.
	7. IN WATER LOGGED AREAS, PIPES TO BE BEDDED WITH SINGLE SIZED OR GRADED AGGREGATES AS PER CLAUSE 430.1 AND 216 OF TECHNICAL SPECIFICATIONS AND/OR ANCHOR BLOCKS AS MAY BE DIRECTED ON SITE BY THE ENGINEER.
	LEGEND:
x	PROPOSED PIPELINE
	PIPE INVERT PROFILE
	- EXISTING ROAD
	AIR VALVE
	DAV – DOUBLE AIR VALVE
	× − washout
	₩ WO1 - WASHOUT TYPE 1
	WO2 - WASHOUT TYPE 2
	DN – NOMINAL DIAMETER
	PN – NOMINAL PRESSURE VB – VERTICAL BEND
	HB - HORIZONTAL BEND
	- EXISTING STRUCTURE
	ER – EARTH ROAD
	GR – GRAVEL ROAD
	LETE - CUT
	FOR CONSTRUCTION
	signed CMTS
	REV R E V I S I O N S SIGN DATE APPROVED
	CHECKED
	CHECKED
	CHECKED
	CO ISSUED FOR CONSTRUCTION BY CHECKED
	CLIENT
	TANA WATER WORKS DEVELOPMENT AGENCY P. O. BOX 1292-10100 NYERI
	PROJECT
	DESIGNS FOR AUGMENTATION OF TIGITHI-HUMUKA WATER PROJECT
	Civil/Structural Engineers
	TANA WATER WORKS
	DEVELOPMENT AGENCY P. O. BOX 1292-10100 NYERI
	Drawing Title MWIYOGO TANK SUPPLY
	LINE 2 PLAN AND PROFILE (SHEET 2 OF 2)
	Designed by KNG Drawn by MK
	Checked by JMM Approved by
	Scale AS SHOWN (A1) Date SEPTEMBER 2023
	Scale         As         SHOWN         (A1)         Date         SEPTEMBER         2023           Job         No.         1         ACAD         File:         PD         STATUS         DRAWING         NoJWWDA/THWP/MTS2/02REV         C0         REV